


SEWBO BR OROUGH WAT DEPARTMENT

C-502	C-501	C-102	C-101		
erosion control details	WATER DETAILS	PROFILE	LEGEND AND SITE PLAN	COVER SHEET	

SHEET NO.

TITLE

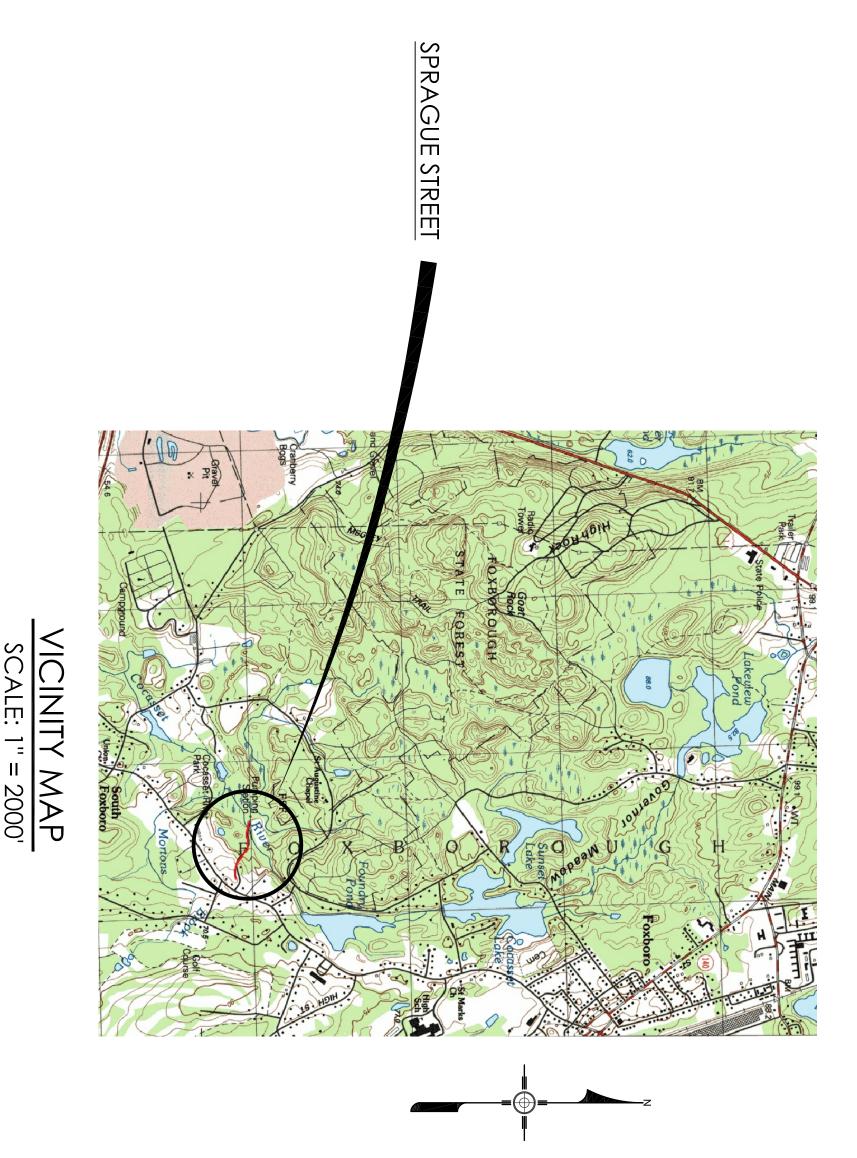

WILLIAM KEEGAN JR **ADMINISTRATOR**

BOARD OF WATER COMMISSIONERS

RICHARD M. PACELLA JR MICHAEL P. STANTON ROBERT T. GARBER

WATER SUPERINTENDENT

ROBERT B. WORTHLEY

REPLACEMENT

PUMP STATION NC

WATER MAIN

BOARD OF SELECTMEN

VIRGINA M. DAVID S. FELDMAN JAMES J DHN R. GREY COPPULA **Devells**

INVis


DECEMBER 2015 **DOCUMENTS**DO NOT REVISE

CHRISTOPHER P. MITCHELL

ORIGINAL SHEET - ARCH D


Project Number: 1951126

DECEMBER 2015

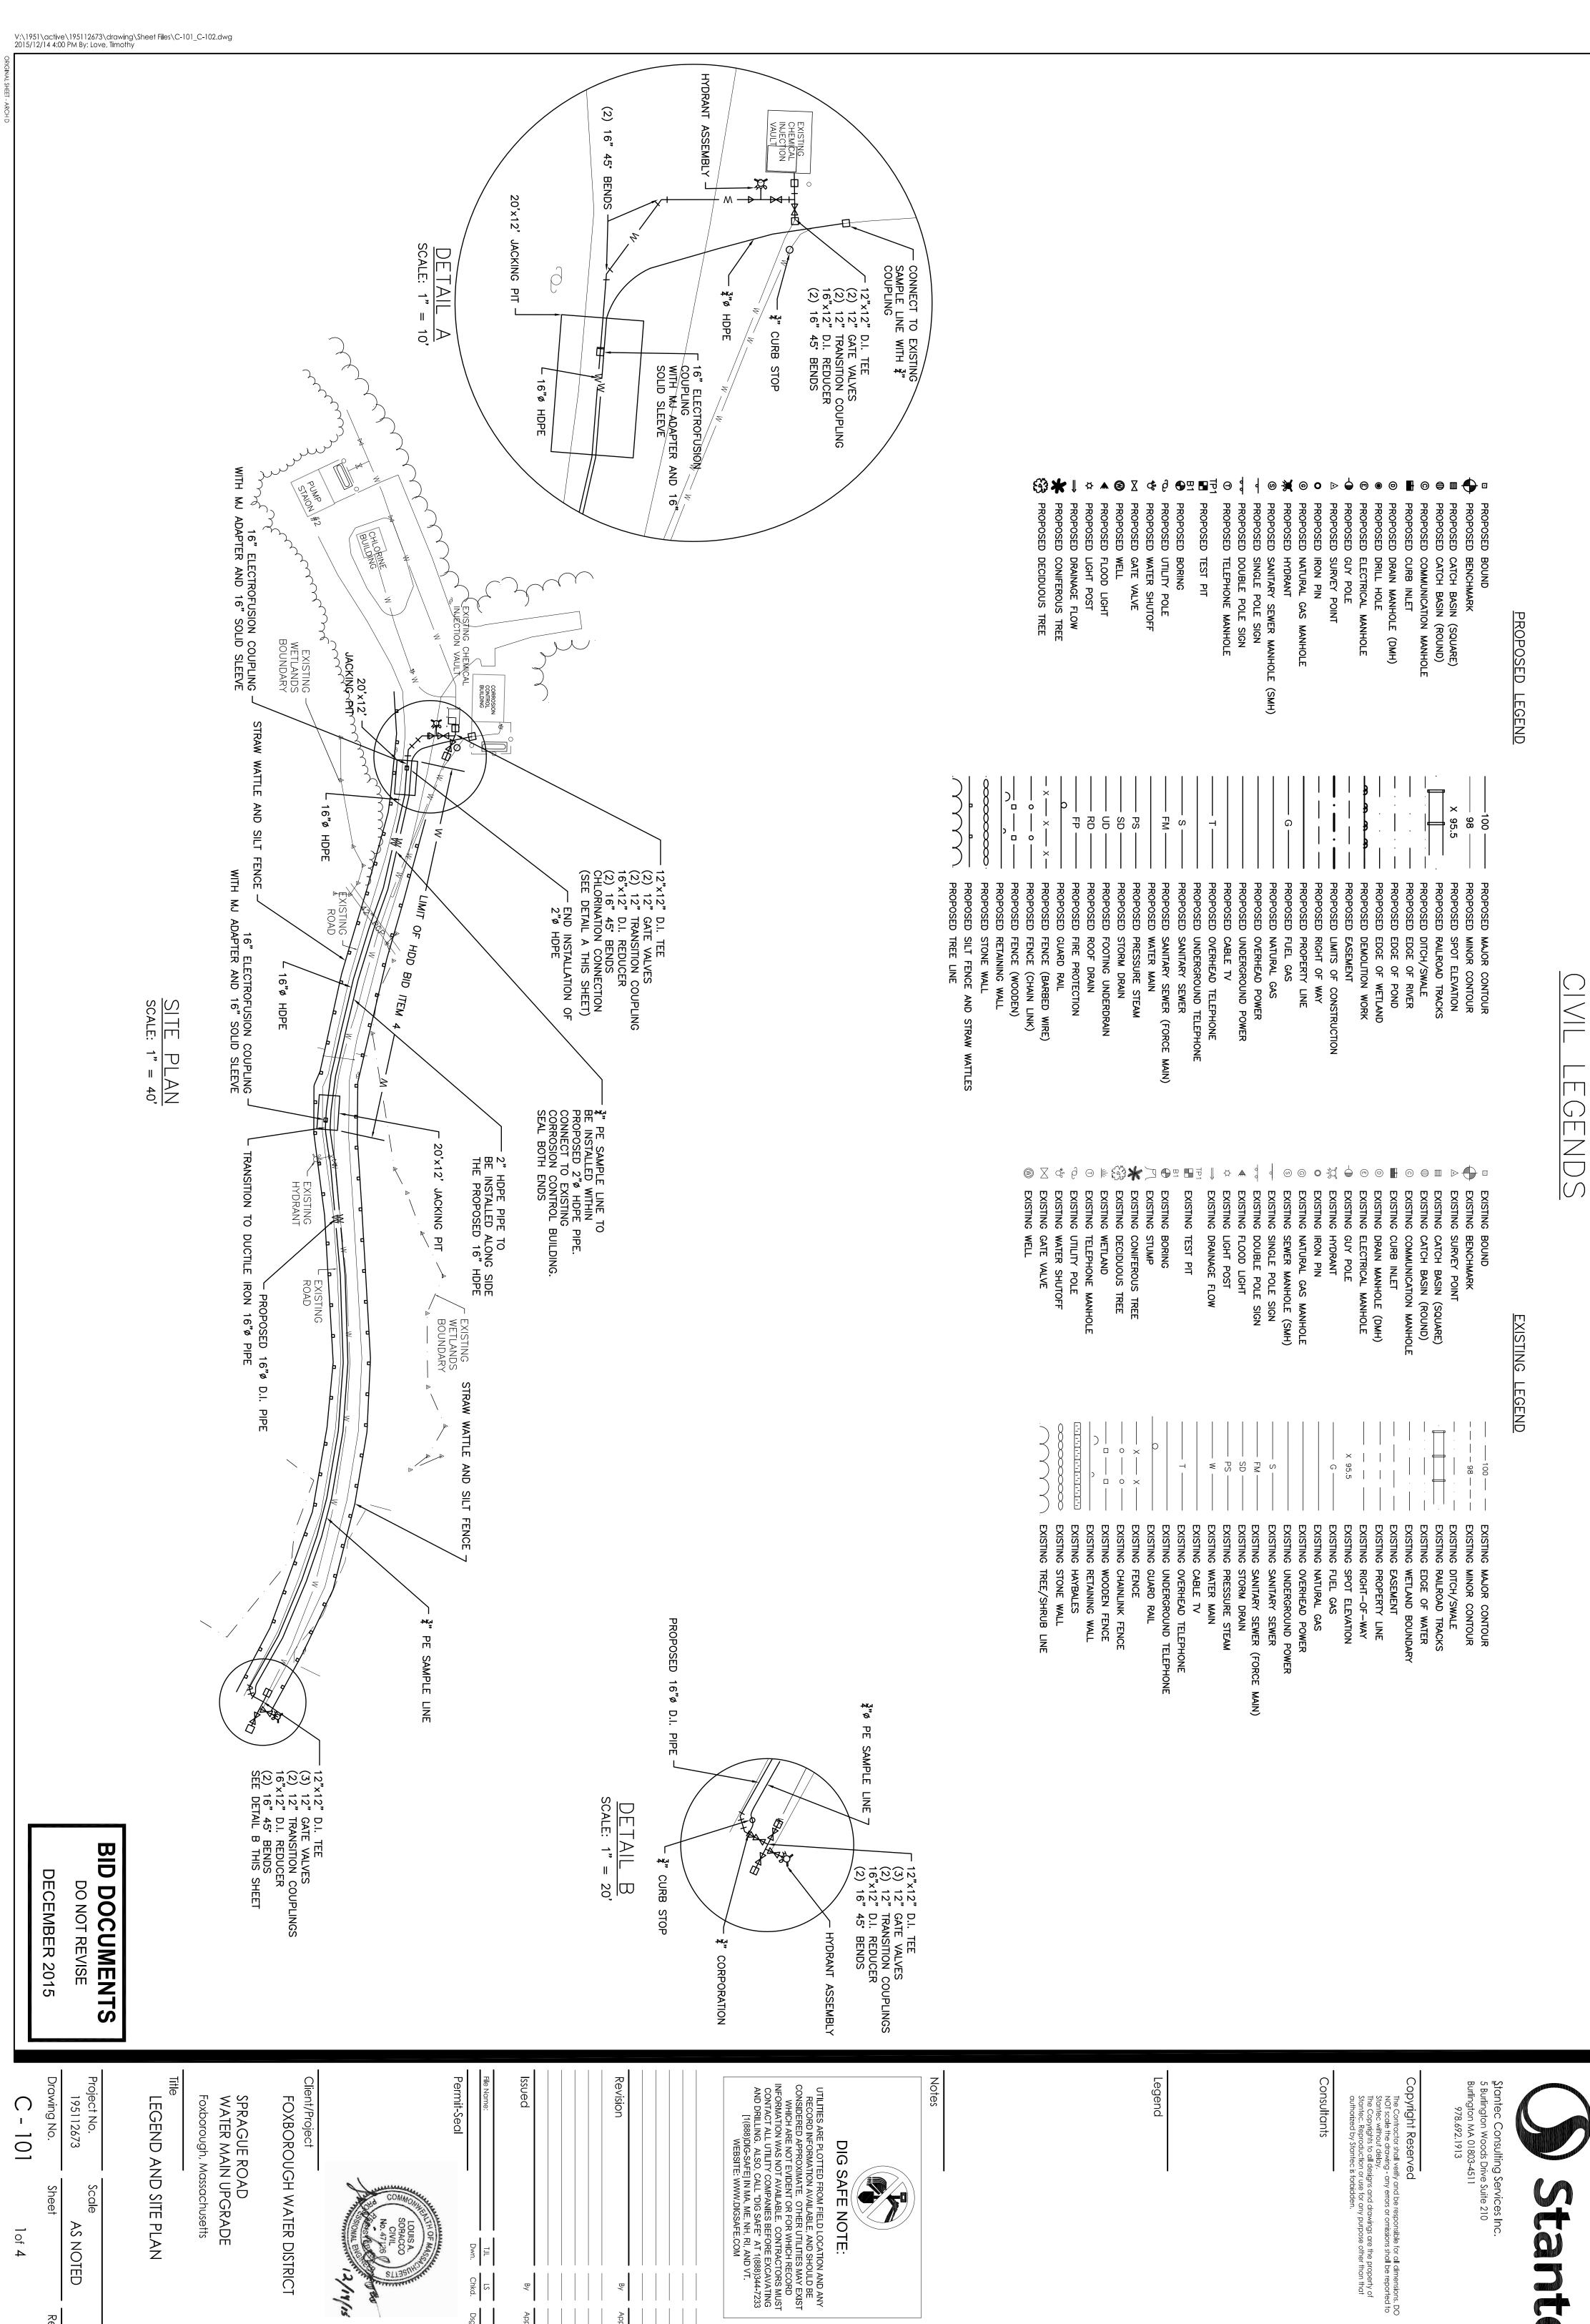

Revision

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LINE SIZE BY 6"
MJ ANCHOR TEE

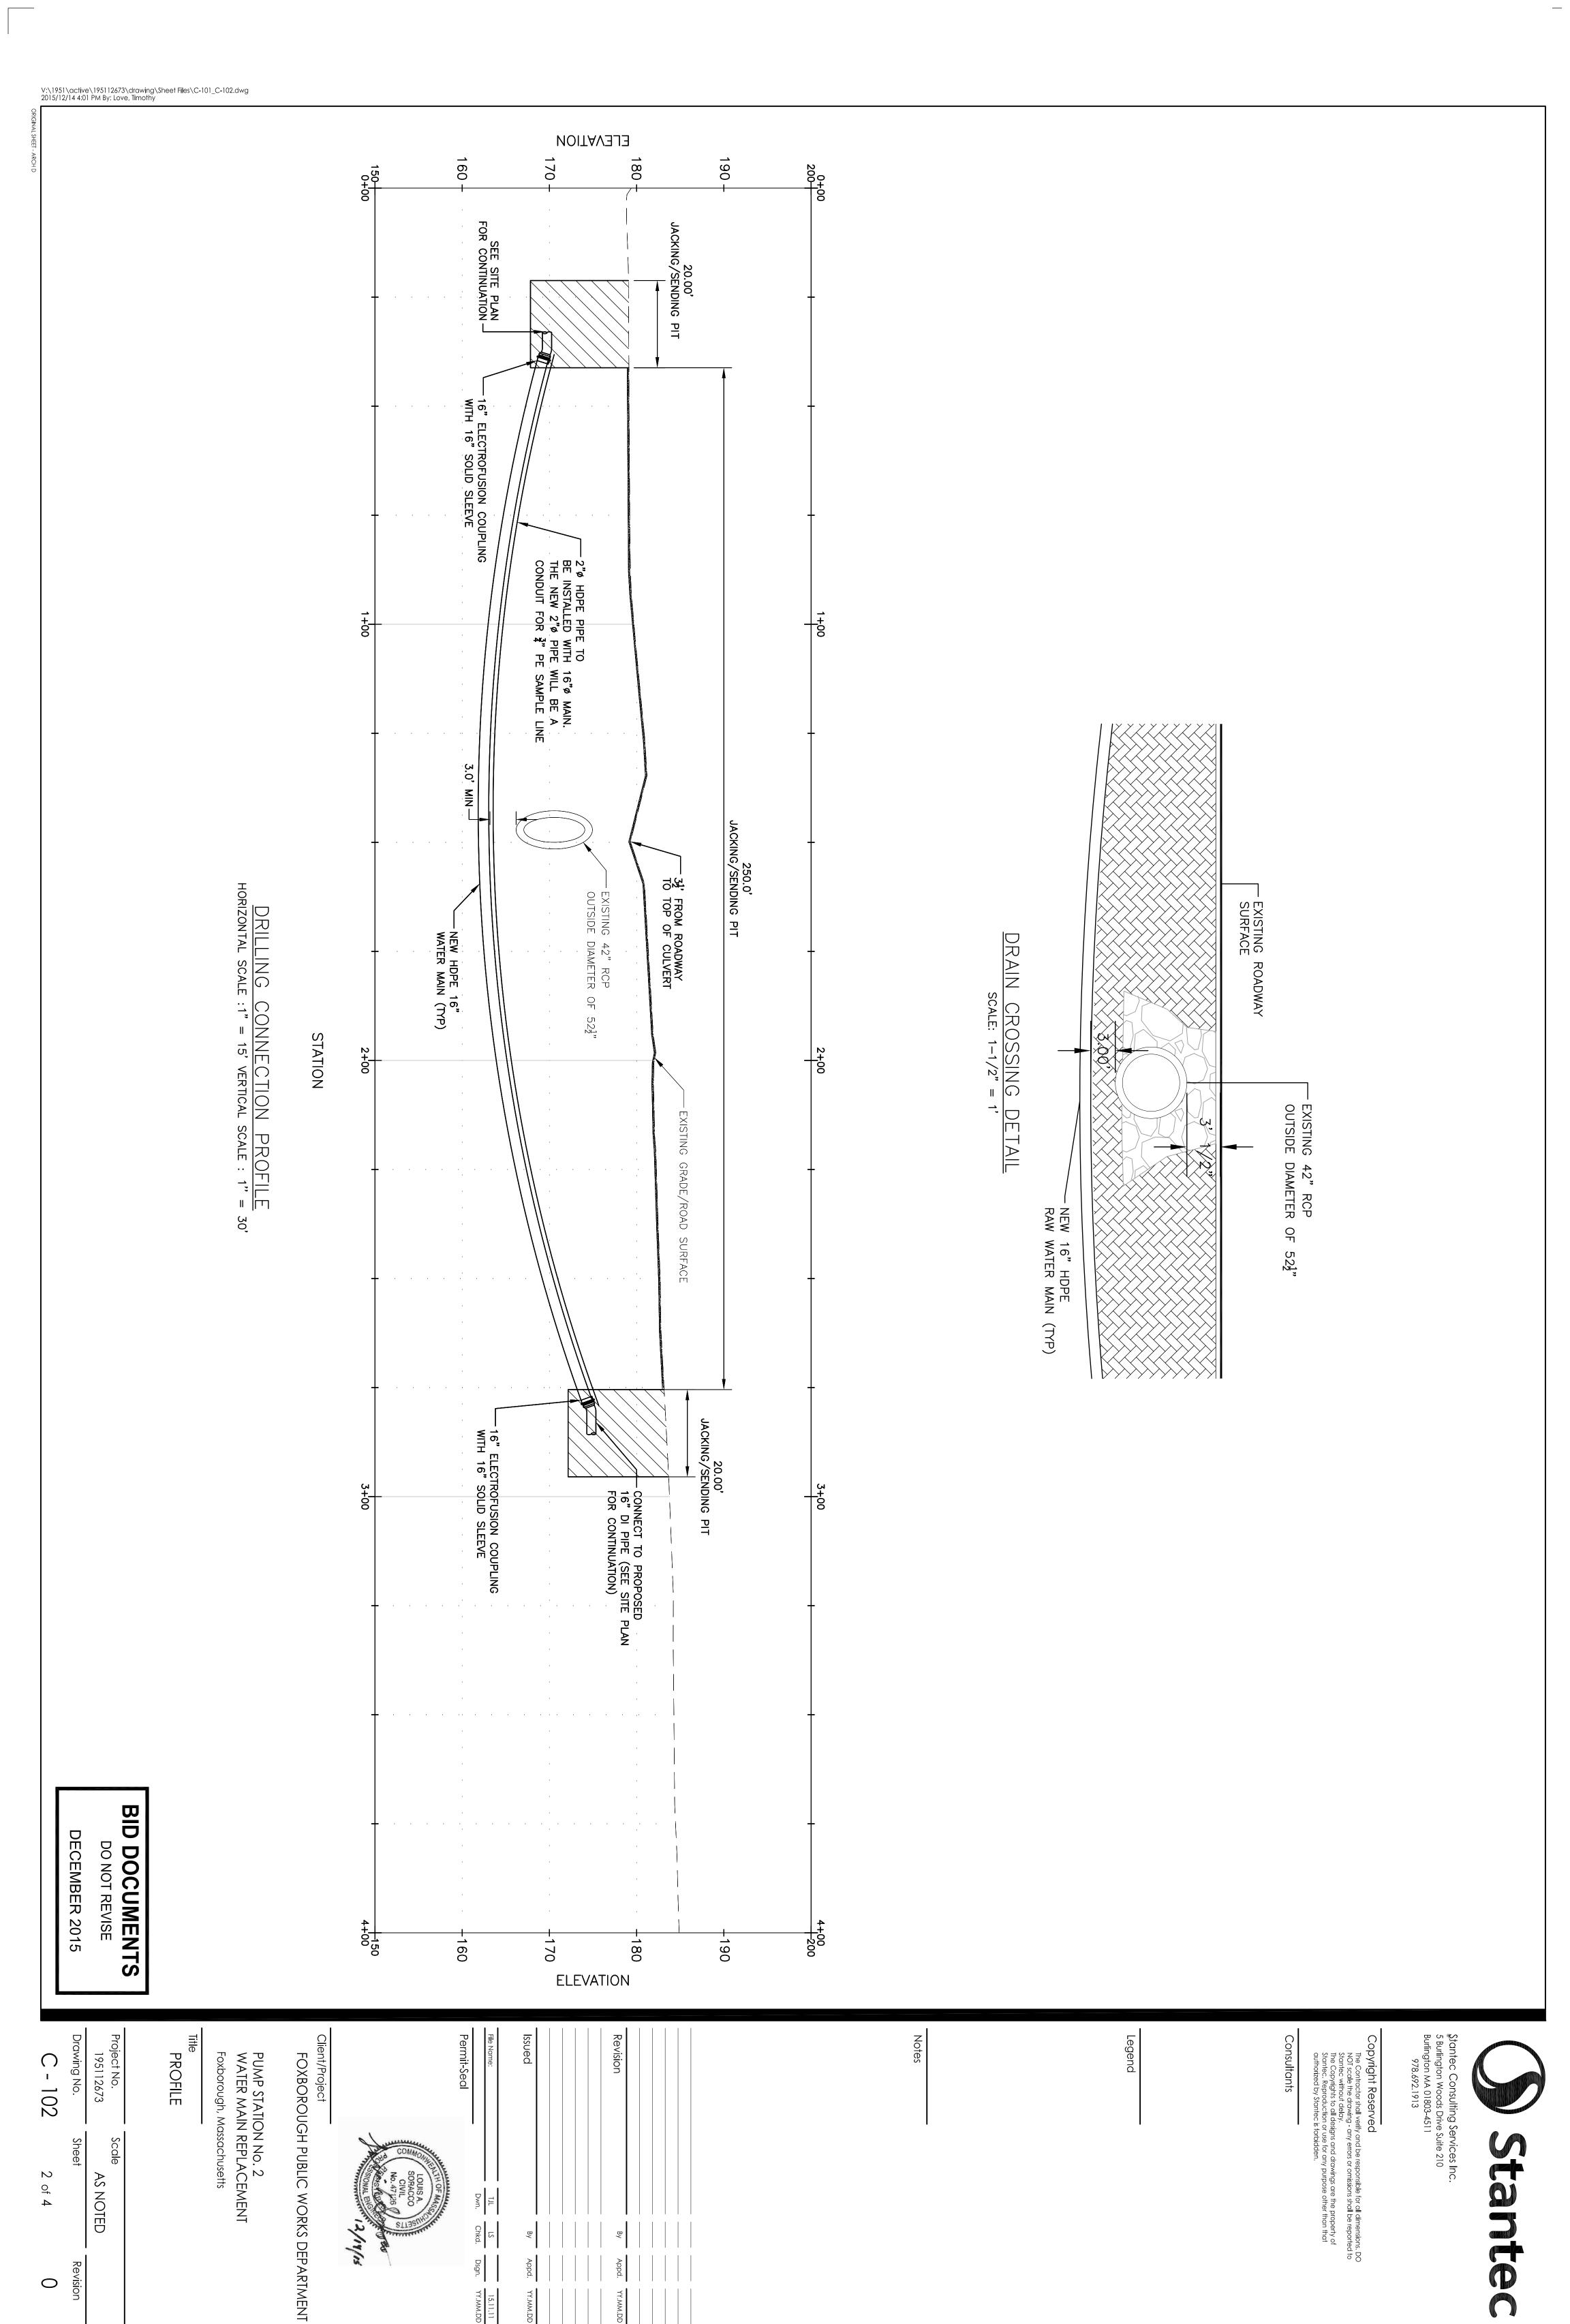1" CURB STOP WITH DRAIN

1" CORPORATION TOP OF MAIN

WATER MAIN

NOTE: HDPE INSTALLATION REQUIRES ELECTROFUSION CORPORATION SADDLE WITH 1/4 BEND TAPPED ON TOP OF PIPE.

VALVE BOX

COCK FOR (

REQUIRES ELECTROFUSION CORPORATION SADDLE RESSION FITTINGS, AND REDUCING BUSHING.

PAVEMENT RESTORATION

Permit-Seal

Dsgn.


NTRY

6" MJ WITH MEGALUGS -COARSE GRAVEL OR PEASTONE (7 FT MIN.)

HYDRANT

ASSEMBLY DETAIL

MJ GATE VALVE WITH MEGALUGS

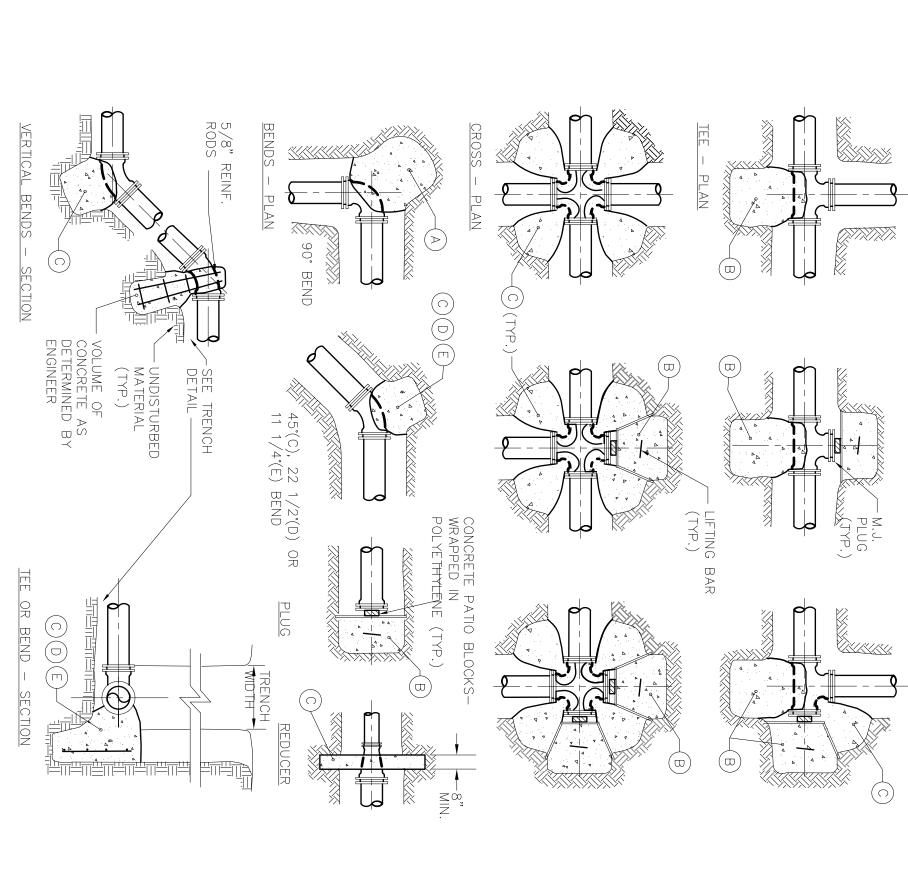

OTHE TEST PRES FOR ABOV REAC	TEST	PRE	SSUR	Ε =	100	PSIG		— RE,	
OTHER TEST PRESSURES FOR THE ABOVE REACTIONS					®	\triangleright	TYPE	REACTION	
		0.13	0.25	0.48	0.65	0.89	4,"		
TEST PR TEST PR NSTANC		0.30	0.60	1.19	1.55	2.19	o,"		
ESSURE Essure AT 2		0.54	1.08	2.12	2.76	3.92	Ω,		
TO BE SOO PSI		0.77	1.54	3.01	4.19	5.57	10"		
200 P OF CO RECTLY TEST F		1.19	2.37	4.66	6.09	8.62	12"		
SI MIN. PROPOI PRESSUR		1.52	3.01	5.91	8.37	10.91	14"	PIPE SIZE	
AT LOW THRUS RTIONAL RE FOR		2.12	4.25	8.34	10.89	15.41	16"	SIZE	
V END C ST BLOC _ TO TH ABOVE		2.51	4.97	9.71	13.87	18.02	18,"		
OF THE KING FO E ABOV NUMBER		3.33	6.64	13.02	17.01	24.06	20"		
TEST PRESSURE TO BE 200 PSI MIN. AT LOW END OF THE TEST SECTION. SQUARE FEET OF CONCRETE THRUST BLOCKING FOR OTHER TEST PRESSURES IS DIRECTLY PROPORTIONAL TO THE ABOVE TABLE. FOR INSTANCE, AT 200 PSI TEST PRESSURE FOR ABOVE NUMBERS DOUBLE.		4.79	9.56	18.75	24.49	34.64	24"		
		7.45	14.85	29.13	38.06	53.83	30"		
		10.71	21.35	41.88	54.72	77.39	36"		

NOTES:	7 7 7 7 7 7 7 7 7 7 7 7 7 7 7 7 7 7 7 7

I. FOUR THRUST BLOCKS AGAINST UNDISTURBED MATERIAL. WHERE TRENCH WALL HAS BEEN DISTURBED, EXCAVATE LOOSE MATERIAL AND EXTEND THRUST BLOCK TO UNDISTURBED MATERIAL NO JOINTS SHALL BE COVERED WITH CONCRETE. 2. ON BENDS AND TEES, EXTEND THRUST BLOCKS FULL LENGTH OF FITTING.

4. REQUIREMENTS OF THE ABOVE TABLE PRESUME MINIMUM SOIL BEARING OF 1 TON PER SQUARE FOOT, AND MAY BE VARIED BY THE ENGINEER TO MEET OTHER CONDITIONS ENCOUNTERED. 3. PLACE CONCRETE PATIO BLOCKS IN FRONT OF ALL PLUGS BEFORE POURING THRUST BLOCK.

ALL FITTINGS SHALL BE WRAPPED IN POLYETHYLENE OR BUILDING PAPER PRIOR TO INSTALLATION CONCRETE RESTRAINT.

5. MEGALUG RETAINER GLANDS ARE REQUIRED FOR ALL MECHANICAL JOINTS. THESE GLANDS DO NOT REDUCE THE REQUIREMENTS FOR THRUST RESTRAINT.

8. THRUST RESTRAINT IS REQUIRED FOR ALL TEES, BENDS, REDUCERS, CAPS, PLUGS, OR CROSSES 9. INSTALL LIFT HOOKS INTO THRUST BLOCKS AT END CAPS AND PLUGS. 7. THREADED ROD SHALL BE ANSI A242 FY50 PIPE RESTRAINT NUTS TO MATCH AWWA C111. THREADED RODS AND NUTS TO BE FIELD COATED WITH BITUMINOUS PAINT.

THRUST BLOCK DETAILS NOT TO SCALE

CURB OR ROAD FACE

- CURB BOX AND
COVER LOCATION
TO BE DETERMINED
BY OWNER
- FINISH GRADE

OPERATING STEM

THE CONTRACTOR SHALL NOTIFY "DIG SAFE" 1-888-344-7233 AT LEAST 72 HOURS PRIOR TO BEGINNING THE WORK. ARE BASED ON THE BEST
AND MAY NOT BE IN THE EXACT
Y NOT BE SHOWN AT ALL. THE
LELY RESPONSIBLE FOR THE
SATION, PERSONALLY, OF ALL
S COMPLETE SATISFACTION

THRUST BLOCK SCHEDULE SQUARE FEET OF CONCRETE THRUST BLOCKING BEARING ON UNDISTURBED MATERIAL

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Stantec Consulting Services Inc.
5 Burlington Woods Drive Suite 210
Burlington MA 01803-4511
Tel. 978.692.1913
www.stantec.com

Stanten

Consultants

WATER MAINS SHALL WHEREVER POSSIBLE BE LAID <u>INDER</u> EXISTING SEWERS AND SEWER SERVICES, AND <u>UNDER</u> EXISTING DRAINS, GAS MAINS, TELEPHONE CABLES, CTRIC CABLES, OR OTHER WATER MAINS AS SHOWN THE PLANS UNLESS DIRECTED OTHERWISE BY THE ENGINEER.

PLANS CHALL BE

TR MAINS SHALL BE

ES'-O" FROM FINISH GRADE
ECESSARY NEW WATER LINES
EATER DEPTH TO CLEAR OBS
AL COST. MINIMUM CLEARAN
AND ON THE DRAWINGS MUST
COR MUST OBTAIN APPROVA
AND WATER LINES WITH
ANY WATER LINES
OF MINIMUM
INDIC BE INSTALLED AT A MINIMUM VISH GRADE TO TOP OF PIPE.

VATER LINES WILL BE INSTALLED CLEAR OBSTACLES AT NO STALLED WITH THE ENGINEER OF UTILITIES OF THE ENGINEER OF COVER MUST MINIMUM DEPTH OF COVER MUST TENT INDICATED ON THE ENGINEER.

MEGALUGS SHALL BE PROVIDED FOR MECHANICAL JOINTS ON BENDS, TEES, VALVES AND HYDRANTS WHERE SHOWN THE CONTRACTOR SHALL EXCAVATE SUFFICIENTLY AHEAD OF HIS PIPE INSTALLATION SO AS TO DETERMINE WHETHER TO RAISE OR LOWER THE PROPOSED WATER MAIN SUCH THAT IT WILL CLEAR EXISTING UTILITIES.

Legend

PLUGS, CAPS, ON THE DRAWINGS.

THE CONTRACTOR SHALL BE RESPONSIBLE FOR CONTACTING THE APPROPRIATE UTILITY COMPANY TO SECURE UTILITY POLES IN AREAS WHERE NEW WATER MAIN IS TO BE INSTALLED CLOSE TO POLES.

THE CONTRACTOR SHALL INSTALL NEW WATER SERVICES TO PROPERTY LINE AND RECONNECT TO EXISTING SERVICE. LOCATION TO BE AS DIRECTED BY ENGINEER. L FENCES, MAIL BOXES, SIGNS, WALKS, CURBS, ETC. FALL BE REMOVED AND REPLACED AS NECESSARY TO MPLETE THE WORK. THE CONTRACTOR SHALL TAKE L NECESSARY PRECAUTIONS TO AVOID DISTURBING ONE WALLS AND TREES DURING CONSTRUCTION. THE DISTURBING STOP ALL SUCH WORK SHALL BE INCLUDED UNDER ATTER MAIN ITEMS.

Notes

HE CONTRACTOR SHALL NOT OPEN OR CLOSE ANY VALVES WHICH HOLD WATER IN THE SYSTEM. THE WATER DEPARTMENT WILL, UPON 24 HOURS NOTICE FROM THE CONTRACTOR, OPEN AND/OR CLOSE ANY VALVES REQUIRED OR DRAINING OR ADMITTING WATER TO VARIOUS SECTIONS OF THE MAINS.

ALL DISTURBED AREAS BEYOND PAYMENT LIMITS SHALL BE RESTORED AT NO ADDITIONAL COST.

ANY WATER THAT IS PUMPED AND DISCHARGED FROM THE TRENCH AND/OR EXCAVATION AS PART OF THE CONTRACTOR'S WATER HANDLING SHALL BE FILTERED BY AN APPROVED METHOD PRIOR TO ITS DISCHARGE INTO A RECEIVING WATER OR DRAINAGE SYSTEM.

PERATIONS. THE VEGICH THAT DISCHARG
MORE THAN 1 FPS
E CHANNEL PERIODI RED THROUGH BALED HAY,
GETATED CHANNEL TO
SULT OF THE CONSTRUCTION
EL SHALL BE CONSTRUCTED
SHALL NOT EXCEED A VELOCITY
T SHALL BE CLEARED FROM

GOOSENECK FORMED WITH TUBING

5'-0"

CONNECT WITH UNION

· 6" SAND FILL AROUND TUBING

2" MIN.

OMPRESSION TTING

PE TUBING

ORATION RESSION FITTINGS

TYPICAL TRENCH DETAIL ETIC TRACER TAPE MOUNDED, COMPACTED GRAVEL FREE OF WOOD, FOREIGN MATERIALS OR STONES EXCEEDING 6" Ø NO ROCK SHALL PROJECT INSIDE OF TRENCH LIMITS FINISH GRADE

- PROVIDE FOR OPERATING
CURB STOP WITH WRENCH
CURB STOP ROD

STANDARD SLIDE TYPE VALVE BOX AND COVER

BID DOCUMENTS DO NOT REVISE

DECEMBER 2015

PUMP STATION No. 2
WATER MAIN REPLACEMENT
Foxborough, Massachusetts

FOXBOROUGH PUBLIC WORKS DEPARTMENT

Client/Project

12/14/15

Project No. 195112673 Drawing No. WATER DETAILS Sheet Scale AS NOTED

C-501 3 of 4

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Revision

will be

spected

is of failure and necessary

<u>ا</u> و

s or after heavy rains and Mulch will be held down

checked for cracks, tears, or leath the blanket shall be regraded ontinuous contact between the damaged fabric.

30 days

of

seeded and In finished. V Vols are implem

from October 15 to May 1 v continue through this

es must be in place prior

s of hay or straw. Slopes ov anket or its equivalent. d specifically for the various

ual grass


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Daily.


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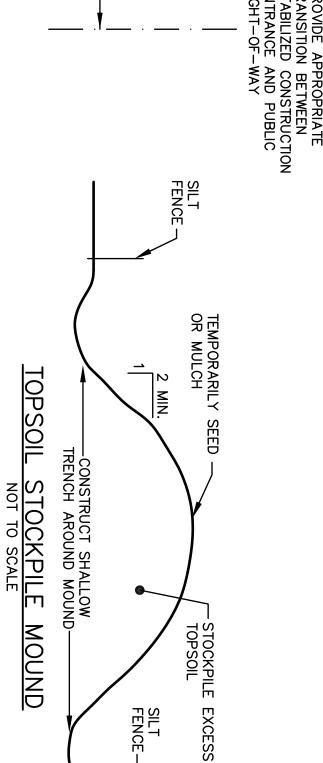
by



SILT FENC

STRAW WATTLE DETAIL NOT TO SCALE

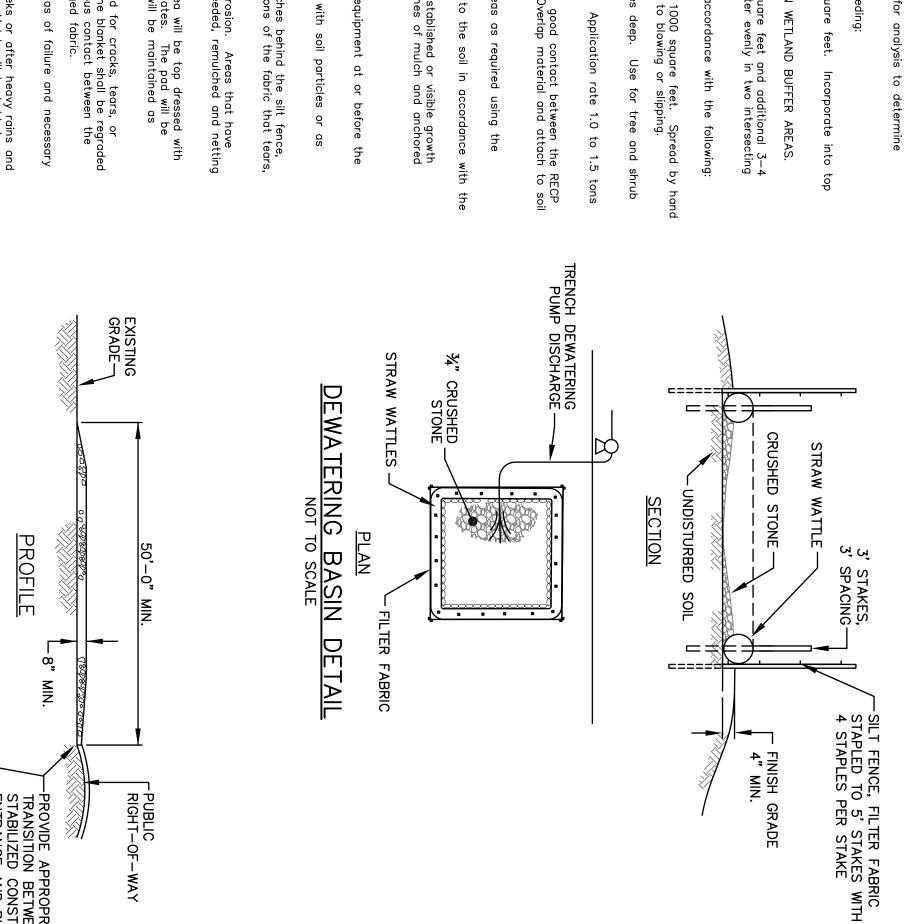

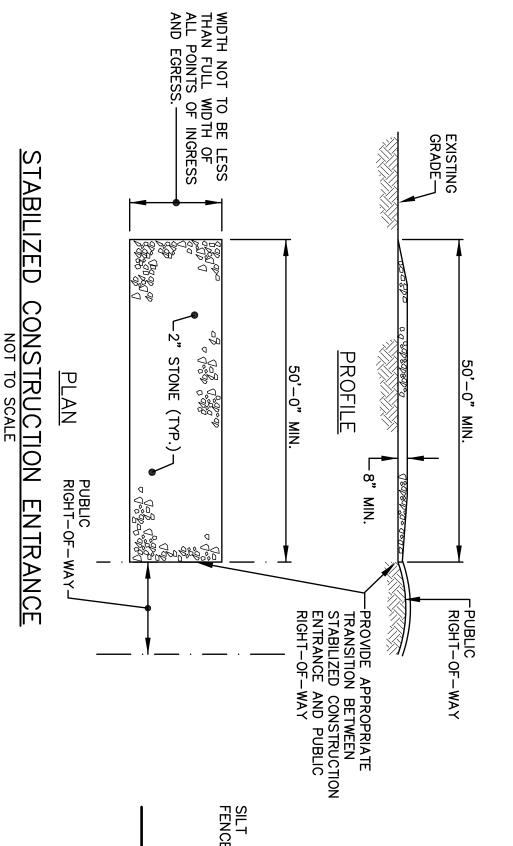

EXISTING GROUND -

Practice	Weekly (Month/Day — M/D) (Month/Day — M/D)	Daily (Month/Day — M/D)
Diversion Dike / Swale	×	×
Erosion Control Blanket	×	×
Fertilizer	NOT ALLOWED	NOT ALLOWED
Mulch	×	×
Mulch Anchoring	×	×
Seeding	X	×
Silt Fence & Straw Wattle Barrier	X	×
Stabilized Stone Staging Area	X	×
Topsoil Stockpile	×	×

NOTES:
1. The Contractor shall inspect all erosion prevention and sediment control features per the table above, and within 24 hours of any storm resulting in a discharge of stormwater from the site.

2. For final cleanup the coordinator shall ensure that all temporary measures have been removed upon project completion or site stabilization, whichever occurs first.

EROSION CONTROL CHART OF INSPECTION

BID DOCUMENTS DECEMBER 2015 DO NOT REVISE



Consulting Services Inc. surlington Woods Drive Suite 210 rlington MA 01803-4511 978.692.1913

FERTILIZER

OULD NOT

ΒE

LIED IN

WETLAND BUFFER AREAS.

rate of sloped c

f 2 pounds per areas of 45% of

1000 square feet and additional 3—4 and greater evenly in two intersecting

of 75

100

1000

iare feet.

: Application rate — Anchor on slopes and

nds per subject

rate

ó

×.

deep. Use for tree and shrub

24 hours

seeding

⊇.

nce with the following:

Apply with hydraulic nd coverage at 80 -

equipment. - 100%.

Application rate 1.0 to 1.5 tons

2'-0" MIN.

WOOD

POSTS, 6-10' O.C.

ANCHOR FABRIC WITH SOIL. TAMP AND BACKFILL

2"x2" STAKES 1'-6" TO 2'-0" IN GROUND

STRAW WATTLE PLACED ON THE CONTOUR

3'-0"

FLOW

ATTACH FABRIC TO POSTS (TYP.)

(RECP) — Maintain down the slope. O

eding

5%

and

מs as required using the

loose

and pin

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to have established or visible growth with 6 inches of mulch and anchored winter.

when

they

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a depth Repair

nes behind the silt fence, ns of the fabric that tears,

sent to the

for analysis to deter

48

final grading

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121	Enman.	
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Client/Project FOXBOROUGH PUBLIC WORKS DEPARTMENT

PUMP STATION NO. 2
WATER MAIN REPLACEMENT Foxborough, Massachusetts

EROSION CONTROL DETAILS

T∺le

Project No. 195112673 Scale AS NOTED

Drawing No. C-502 4 of 4

Sheet

Revision

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